Gordon Head & Laval

ISSUED FOR REZONING/DP COMBINED

CLIENT:

SEBA CONSTRUCTION

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ARCHITECTS:

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LANDSCAPE DRAWING INDEX PERMIT

Sheet No. Sheet Name L0.0 COVER SHEET OVERALL SITE PLAN L0.1 TREE MANAGEMENT PLAN OVERALL IMPERMEABLE SURFACES OVERLAY LAYOUT + MATERIALS PLAN L1.1 GRADING PLAN PLANTING PLAN L1.2 L1.3 SOIL DEPTHS PLAN L2.0 PRECEDENT IMAGES L3.0 PLANT LIST + IMAGES SECTIONS L4.1 SECTIONS DETAILS DETAILS DETAILS DETAILS







GENERAL LAYOUT + MATERIALS NOTES:

- ALL DIMENSIONS ARE METRIC UNLESS OTHERWISE NOTED. VERIFY ALL DIMENSIONS WITH FIELD CONDITIONS. REPORT ANY DISCREPANCIES TO LANDSCAPE ARCHITECT FOR REVIEW AND RESPONSE.
- 2. ALL UTILITIES TO BE STAKED OUT BY CONTRACTOR AND PROTECTED FOR DURATION OF CONSTRUCTION PERIOD.
- 3. UNLESS OTHERWISE NOTED, PROVIDE A MINIMUM 2% SLOPE ON ALL HARD AND SOFT LANDSCAPE AREAS TO ENSURE POSITIVE DRAINAGE AWAY FROM BUILDINGS OR TO DRAINAGE STRUCTURES. MAXIMUM 3:1 SLOPE IN SOFT LANDSCAPE AREAS.
- 4. THE LAYOUT OF ALL HARDSCAPE ITEMS, SITE FURNISHINGS, BOULDERS, LANDSCAPE LIGHTING, PLANTING BEDS AND OTHER MATERIALS IS TO BE STAKED OUT BY THE CONTRACTOR AND APPROVED BY THE LANDSCAPE ARCHITECT PRIOR TO INSTALLATION.
- 5. ALL SUBSTITUTIONS OF SPECIFIED MATERIALS TO BE APPROVED BY LANDSCAPE ARCHITECT.
- 6 THIS PLAN IS "NOT FOR CONSTRUCTION" AND IS TO BE SUBMITTED FOR REVIEW TO ENGINEERING SERVICES A MINIMUM OF 8 WEEKS PRIOR TO THE START OF ANY CONSTRUCTION PROPOSED FOR PUBLIC PROPERTY. NO WORK ON PUBLIC PROPERTY MAY BEGIN UNTIL SUCH PLANS RECEIVE "FOR CONSTRUCTION" APPROVAL AND RELATED PERMITS ARE ISSUED. PLEASE CONTACT ENGINEERING, DEVELOPMENT SERVICES AND/OR YOUR ENGINEERING, BUILDING SITE INSPECTOR FOR DETAILS.
- 7. MAINTENANCE AND IRRIGATION WILL BE PROVIDED TO ALL AREAS.








TREE MANAGEMENT PLAN

SYMBOL

DESCRIPTION

 $\left(\begin{array}{c} \cdot \end{array}\right)$

EXISTING TREE TO BE REMOVED Refer to Arborist Report

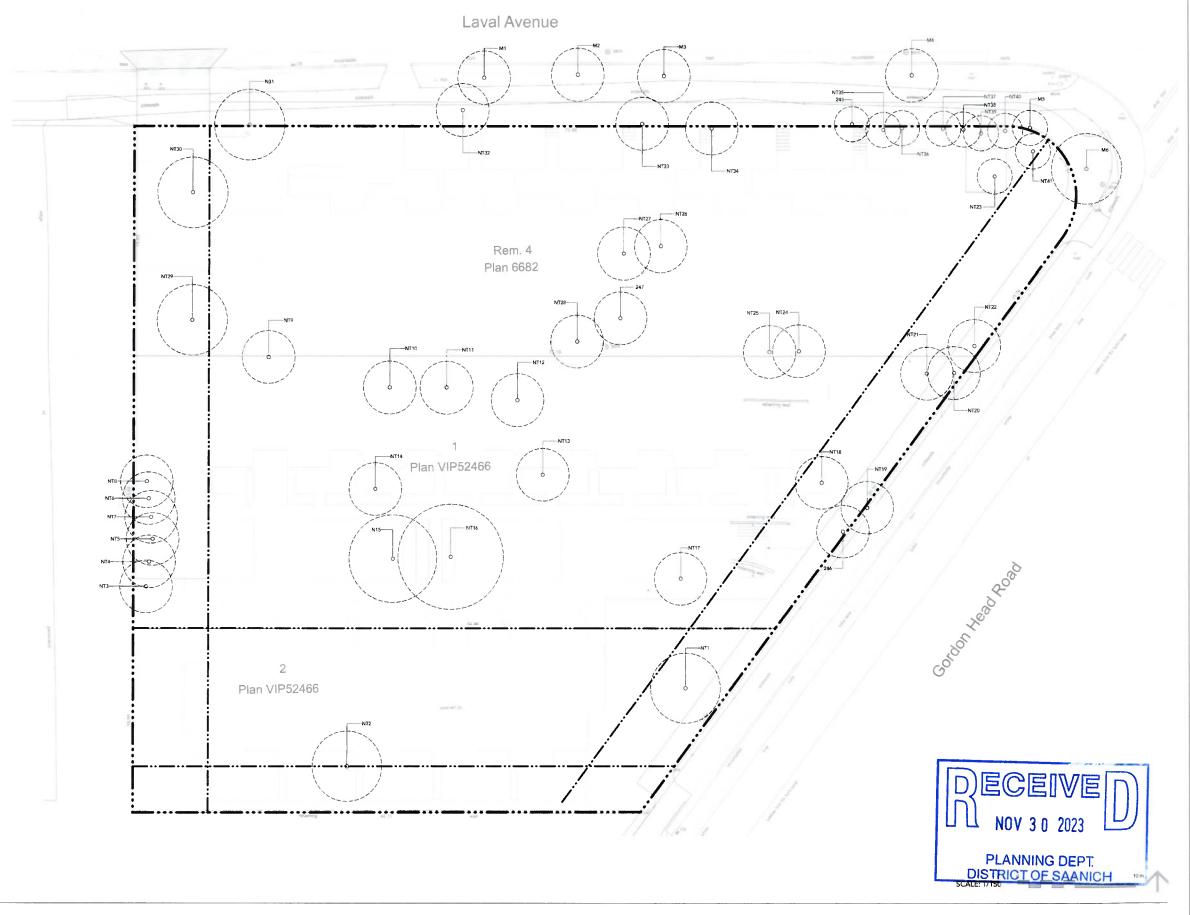



IMPERMEABLE X ABSORBENT SURFACES LEGEND

IMPERMEABLE PAVING AREA 1338.60 sq m

IMPERMEABLE BUILDINGS 1665.18 sq m

ABSORBENT SURFACES ON SLAB 544.82 sq m

ABSORBENT SURFACES ON GRADE 335.1 sq m LAVAL AVENUE

BIKE LANE







GENERAL LAYOUT + MATERIALS NOTES:

- 1. ALL DIMENSIONS ARE METRIC UNLESS OTHERWISE NOTED. VERIFY ALL DIMENSIONS WITH FIELD CONDITIONS. REPORT ANY DISCREPANCIES TO LANDSCAPE ARCHITECT FOR REVIEW AND RESPONSE.
- ALL UTILITIES TO BE STAKED OUT BY CONTRACTOR AND PROTECTED FOR DURATION OF CONSTRUCTION PERIOD.
- 3. UNLESS OTHERWISE NOTED, PROVIDE A MINIMUM 2% SLOPE ON ALL HARD AND SOFT LANDSCAPE AREAS TO ENSURE POSITIVE DRAINAGE AWAY FROM BUILDINGS OR TO DRAINAGE STRUCTURES. MAXIMUM 3:1 SLOPE IN SOFT LANDSCAPE AREAS.
- 4. THE LAYOUT OF ALL HARDSCAPE ITEMS, SITE FURNISHINGS, BOULDERS, LANDSCAPE LIGHTING, PLANTING BEDS AND OTHER MATERIALS IS TO BE STAKED OUT BY THE CONTRACTOR AND APPROVED BY THE LANDSCAPE ARCHITECT PRIOR TO INSTALLATION.
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 APPROVAL AND RELATED PERMITS ARE ISSUED. PLEASE CONTACT ENGINEERING, DEVELOPMENT SERVICES AND/OR YOUR ENGINEERING, BUILDING SITE INSPECTOR FOR DETAILS.
- 7. MAINTENANCE AND IRRIGATION WILL BE PROVIDED TO ALL AREAS.

MATERIALS LEGEND



EXTENT OF UNDERGROUND PARKING








GENERAL GRADING NOTES:

- 1. ALL UTILITIES TO BE STAKED OUT BY CONTRACTOR AND PROTECTED FOR DURATION OF CONSTRUCTION PERIOD.
- UNLESS OTHERWISE NOTED, PROVIDE A MINIMUM 2% SLOPE ON ALL HARD AND SOFT LANDSCAPE AREAS TO ENSURE POSITIVE DRAINAGE AWAY FROM BUILDINGS OR TO DRAINAGE STRUCTURES. MAXIMUM 3:1 SLOPE IN SOFT LANDSCAPE AREAS.
- THE LAYOUT OF ALL PROPOSED HARDSCAPE ITEMS, SITE FURNITURE, LIGHTING, PLANTING BEDS AND OTHER MATERIALS IS TO BE STAKED OUT BY THE CONTRACTOR AND APPROVED BY THE LANDSCAPE ARCHITECT PRIOR TO INSTALLATION.
- 4. ALL SUBSTITUTIONS OF SPECIFIED MATERIALS TO BE APPROVED BY LANDSCAPE ARCHITECT.
- REFER TO CIVIL FOR EXCAVATION DEPTHS, BACKFILL, AND BASE MATERIAL FOR ALL LANDSCAPE ITEMS SHOWN ON PLAN.
- 6. SLOPE SHALL MATCH EXISTING GRADE ALONG ALL PROPERTY LINES.
- 7. REFER TO CIVIL ENGINEER'S PRECISE GRADING PLANS FOR SITE GRADING PLANS FOR SITE GRADING, DRAINAGE, AND UTILITY LOCATIONS. IF ACTUAL SITE CONDITIONS VARY FROM WHAT IS SHOWN ON THE LANDSCAPE ARCHITECT'S PLANS, THE CONTRACTOR SHALL CONTACT THE OWNER'S REPRESENTATIVE AND LANDSCAPE ARCHITECT FOR DIRECTION AS TO HOW TO PROCEED.
- 8. THE CONTRACTOR IS RESPONSIBLE FOR VERIFYING THE ACTUAL LOCATION AND ELEVATION IN THE FIELD PRIOR TO BEGINNING CONSTRUCTION. THE CONTRACTOR SHALL PROTECT ALL EXISTING UTILITIES AND SHALL BE RESPONSIBLE FOR ANY DAMAGE TO EXISTING UTILITIES ENCOUNTERED DURING CONSTRUCTION.
- ALL PROPOSED GRADES ARE TO MEET AND BLEND IN WITH EXISTING GRADING AT PROJECT LIMITS, GRADING LIMITS, AND EXISTING SIDEWALK. PRECISE ELEVATIONS INDICATED ON PLANS TO BE VERIFIED IN FIELD TO
- 10.THE DEBRIS CREATED BY LANDSCAPE GRADING OPERATIONS SHALL BECOME THE PROPERTY OF THE CONTRACTOR AND SHALL BE DISPOSED OF LEGALLY OFF SITE.
- 11. FINAL GRADING SHALL BE REVIEWED BY THE LANDSCAPE ARCHITECT IN THE FIELD PRIOR TO INSTALLATION OF PLANTING.

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GRADING LEGEND						
SYMBOL		DESCRIPTION				
EL	0.00	PROPOSED ELEVATION				
EL	0.00	EXISTING ELEVATION				
TW	0.00	TOP OF WALL ELEVATION				
BW	0.00	BOTTOM OF WALL ELEVATION				
TS	0.00	TOP OF STAIRS ELEVATION				
BS	0.00	BOTTOM OF STAIRS ELEVATION				
TF	0.00	TOP OF FENCE ELEVATION				
ТВ	0.00	TOP OF BENCH ELEVATION				
1	%	SLOPE AND DIRECTION				



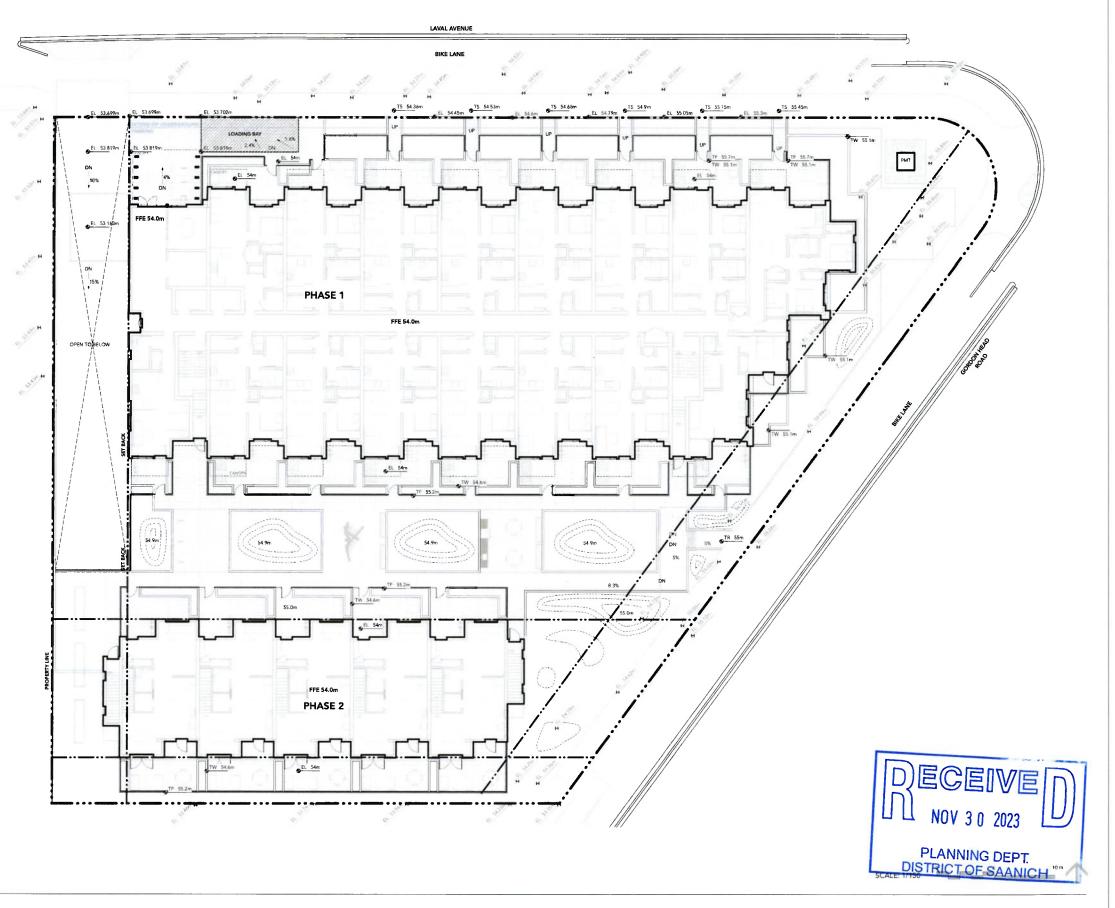

GENERAL PLANTING NOTES:

- ALL PLANTING SHALL BE IN ACCORDANCE WITH BC LANDSCAPE STANDARD, LATEST EDITION
- 2. ALL TREE AND SHRUB AREAS TO BE MULCHED WITH 50MM (2") OF MEDIUM FINE MULCH, LESS THAN 50MM (2") DIAMETER.
- 3. ROOTZONE TO REST ON TAMPED PLANTING SOIL
- 4. SHRUBS: PREPARE PLANTING HOLES AS SPECIFIED. PLANT AT THE SAME GRADE AS NURSERY. WATER AND FERTILIZE AS SPECIFIED. ENSURE POSITIVE DRAINAGE THROUGHOUT PLANTING BED
- 5. TREE SIZE AND SPACING TO BE AS PER CITY OF VANCOUVER ARBORIST
- 6. TREE: PREPARE PLANTING HOLES AS SPECIFIED INSTALL TOP OF ROOTZONE 6" ABOVE FINISHED GRADE OF GROWING MEDIUM. WATER AND FERTILIZE AS SPECIFIED BY NURSERY.
- 7. FINAL SOFTSCAPE AND GRADING LAYOUTS AS WELL AS LOCATION SPACING TO BE APPROVED BY LANDSCAPE ARCHITECTS IN THE FIELD PRIOR TO INSTALLATION
- IN CASE OF A DISCREPANCY BETWEEN PLANT INFORMATION ON THE LIST AND ON THE PLAN, THE LATTER SHALL PREVAIL
- ALL PLANT MATERIAL TO BE MANUALLY WATERED FROM START OF INSTALLATION THROUGH THE END OF THE WARRANTY PERIOD
- 10. INSTALL TREE PROTECTION FENCING AROUND ALL EXISTING TREES TO CITY OF VANCOUVER STANDARDS. INSTALL TREE PROTECTION FENCING ON NEW PLANTING IF PHASED INSTALLATION IS REQUIRED.
- 11. FINAL PLANT SPACING, QUANTITY AND TREE PLACEMENT HAS BEEN REVIEWED TO THE SATISFACTION OF GENERAL MANAGER OF ENGINEERING SERVICES
- 12. ALL PLANTING BEDS TO RECEIVE AUTOMATIC DRIP IRRIGATION







SOIL DEPTH LEGEND

SYMBOL

DESCRIPTION


450mm MAX DEPTH. RAIN GARDEN - 124.34 sq m

150mm H. RECESSED PLANTER - 47.40 sq m 150mm min. total of h.soil depth for groundcovers

600mm H. RECESSED/RAISED PLANTER - 208.56 sq m 600mm min. h. soil depth for shrubs

900mm H. RECESSED/RAISED PLANTER - 250.10 sq m 900mm min. h. soil depth for Trees

RECESSED PLANTER - 288.96 sq m

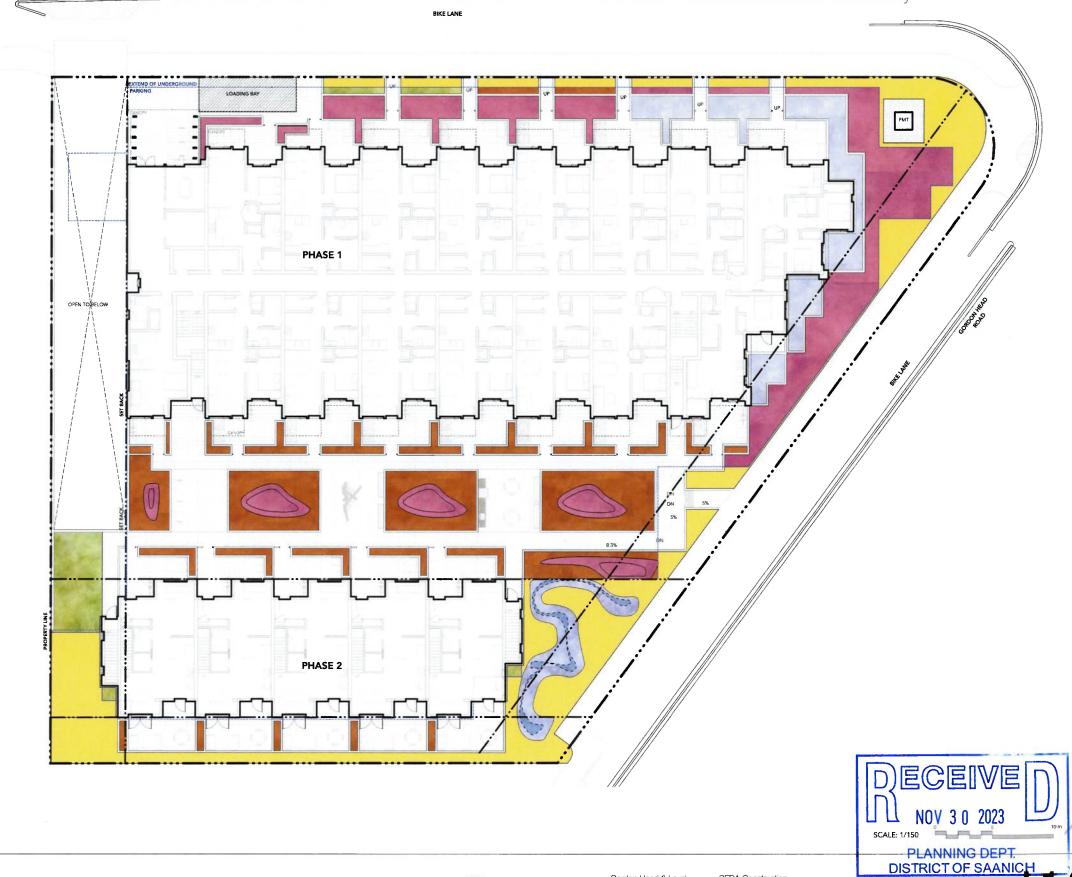
















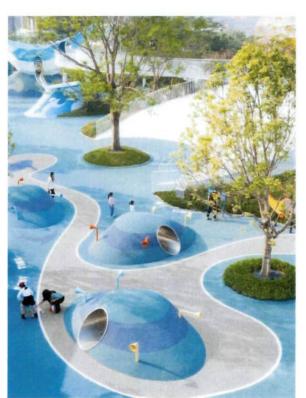













Gordon Head & Laval 3982-84-86 Gordon Head Road Victoria, BC May, 2023

SEBA Construction

DECEIVE

OVERALL PLANT LIST

Symbol DECIDUOUS		Latin Name	Common Name	Scheduled Size	Spacing	Notes
	6	Acer macrophyllum	Big Leaf Maple	5cm cal.	As Shown	B&B Specimen, Mu
	13	Cornus nuttalliii ' Eddie's White Wonder'	Eddie's Pacific Dogwood	8' ht. Min	As Shown	B&B Specimen
♦	3	Ginkgo biloba	Maidenhair Tree	10cm cal.	As Shown	B&B Specimen
	30	Magnolia grandiflora 'Saint Mary'	Saint Mary Southern Magnolia	5cm cal.	As Shown	B&B Specimen, Upi
	4	Quercus garryana	Garry Oak	6cm cal.	As Shown	Mutli-Stem Specime
CONIFERS:						
	2	Pinus nigra	Austrian Pine	3m. ht.	As Shown	B&B Specimen
	9	Pinus contorta	Lodgepole Pine	3m. ht.	As Shown	B&B Specimen, Mu
SHRUBS:						
	12	Aucuba japonica 'Serratifolia'	Sawtoothed Japanese Aucuba	#3 Pot	0.914m o.c.	
-	22	Cornus sericea 'Kelseyi'	Kelsey's Dwarf Red-Osier Dogwood	#3 Pot	0.7 62m o.c.	
000	133	Gaultheria shallon	Salai	#1 Pot	0.457m o.c.	
	24	Lonicera pileata	Box-leaf Honeysuckle	#2 Pot	1.067m o.c.	
- 10fg	49	Rhododendron x 'Purple Gem'	purple gem rhododendron	#3 Pot	0.762m o.c.	Specimen.
**	316	Taxus x media 'Hillii'	Hill's Yew	#3 Pot	0.61m o.c.	B&B Specimen Mult
PERENNIALS,	GRASSES,	GROUNDCOVER:				
*	209	Adiantum pedatum	American Maidenhair Fern	#2 Pot	0.457m o.c.	
	538	Arctostaphylos uva-ursi	Bearberry, Kinnikinick	#1 Pot	0.305m o.c.	
	182	Blechnum spicant	Deer Fern	#2 Pot	0.61m o.c.	
-	12	Carex buchananii	Fox Red Curly Sedge	#2 pot	0.762m o.c.	
	78	Carex obnupta	Slough Sedge	#2 pot	0.762m o.c.	
-	72	Deschampsia caespitosa	Tufted Hair Grass	#2 Pot	0.762m o.c.	
3	20	Hosta x 'Blue Cadet'	Blue Cadet Plantain Lily	#2 Pot	0.61m o.c.	
	51	Iris setosa	Alaskan Iris	#2 Pot	0.457m o.c.	
0	128	Juncus effusus	Soft Common Rush	#2 Pot	0.61m o.c	
	21	Leymus mollis	Dune Grass	#3 Pot	0.762m o.c.	
	9	Liriope spicata	Creeping Lilyturf	#1 Pot	0.381m o.c.	
	48		Dwarf Lupine	#1 Pot	0.457m o.c.	
	27		Adagio Maiden Grass	#3 pot	0.762m o.c.	
00000	551	E LG E	Rewood Sorrel	#1 Pot	0.457m o.c.	
4	73	-	Western sword fern	#3 Pot	0.914m o.c.	
	143		Black-Eyed Susan	#2 Pot	0.457m o.c.	
	200		Autumn Joy Stonecrop	#2 Pot		
	200	Joseph Autumn Joy	Additional state of the state o	#Z FUL	0.61m o.c.	

- ALL PLANT MATERIAL AND LANDSCAPING PRACTICES SHALL BE COMPLIANT WITH THE LATEST EDITION OF THE BCLNA NURSERY STANDARD.

 IN CASE OF DISCREPANCY BETWEEN PLANT INFORMATION ON THE LIST AND ON THE PLAN, THE LATTER SHALL PREVAIL.

 IN FINAL SOFTSCAPE AND GRADING LAYOUTS AS WELL AS LOCATION AND SPACING TO BE APPROVED BY LANDSCAPE ARCHITECT IN THE FIELD PRIOR TO INSTALLATION.
- 4 ALL PLANT MATERIAL TO BE MANUALLY WATERED FROM START OF INSTALLATION THROUGH THE END OF THE WARRANTY PERIOD
 5 INSTALL TREE PROTECTION FENCING AROUND ALL EXISTING TREES TO CITY STANDARDS, INSTALL TREE PROTECTION FENCING ON NEW PLANTING IF PHASED INSTALLATION IS REQUIRED.
- 6. FINAL LOCATION, QUANTITY, TREE SPECIES TO THE SATISFACTION OF THE GENERAL MANAGER OF ENGINEERING.
 7. NEW TREE MUST BE OF GOOD STANDARD, MINIMUM 6 CM CALLIPER AND INSTALLED WITH APPROVED ROOT BARRIERS, TREE GUARDS AND APPROPRIATE SOIL
- 8. ROOT BARRIERS SHALL BE 8'-0" (2 4M) LONG AND 18" (0.46M) DEEP. PLANTING DEPTH OF ROOT BALL MUST BE BELOW SIDEWALK GRADE. NEW STREET TREES TO BE CONFIRMED PRIOR TO ISSUANCE OF THE BUILDING PERMIT.

PLANT IMAGES

DECIDUOUS TREES





Eddie's Pacific Dogwood



















Kelsey's Dwarf Red-Osier Dogwood



Dwarf Southern Magnolia





Hill's Yew



PERENNIALS, GRASSES, GROUNDCOVER





Blue Cadet Plantain Lily

Miscanthus sinensis 'Adagio Adagio Maiden Grass















Lupinus 'Russel Hybrids Dwarf Lupine



Liriope spicata Creeping Lilyturf



Sedum Autumn 'Joy'
Autumn Joy Stonecrop



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Juncus effusus Soft Common Rush

Western Sword Fern

Gordon Head & Laval 3982-84-86 Gordon Head Road Victoria, BC SEBA Construction

Black-Eyed Susan



SECTION 1: CENTRAL COURTYARD
Scale: 1:25


DECEIVE Nov 3 0 2023

PLANNING DEPT.
DISTRICT OF SAANICH

SECTIONS

Issued for Rezoning / DP Combined 23-11-30

Gordon Head & Laval 3982-84-86 Gordon Head Road Victoria, BC SEBA Construction 2318 May, 2023

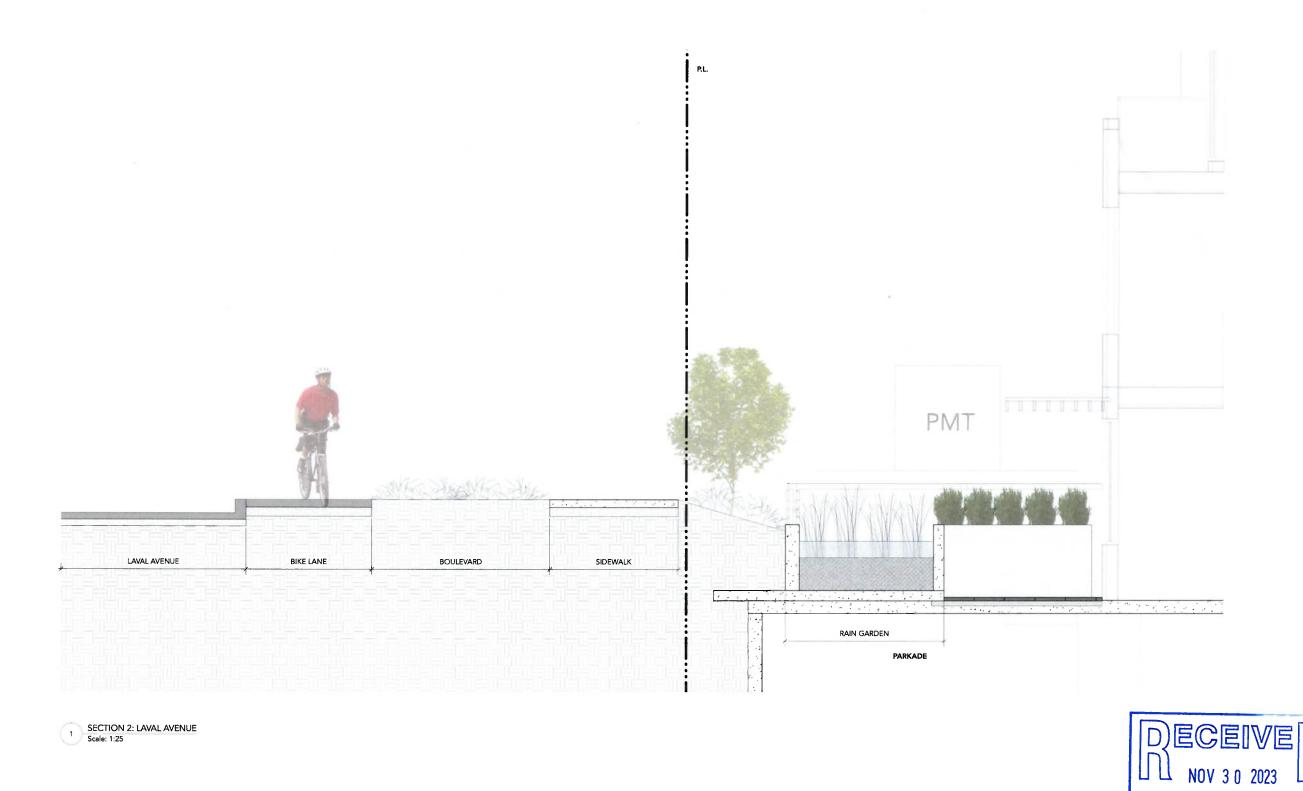


Gauthier + Associates Landscape Architects inc.

Gordon Head & Laval

SEBA Construction 2318 3982-84-86 Gordon Head Road May, 2023 Victoria, BC

PLANNING DEPT.
DISTRICT OF SAANICH


SECTIONS

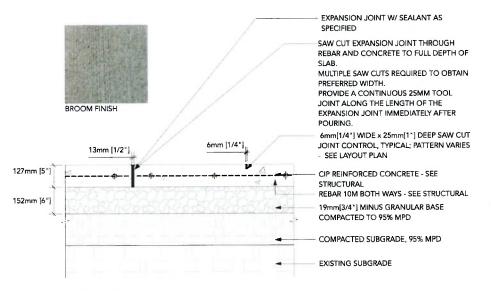

NOTES:

- 1. TROWEL WITH LIGHT SANDBLAST
- 2. SEE TYPICAL LAYOUT PLAN FOR JOINT PATTERN AND BAND WIDTH
- 3. EXP. JOINTS 6096mm [20'0"] O.C. MAX (@ CURB, BUILDING EDGE CUT LINES, CHANGES IN MATERIALS. SPACING TO COINCIDE W/ PATTERN)
- 4, CONTROL JOINTS @ 1524mm [5'0"0] O.C. MAX
- 5. FINAL LOCATIONS TO BE CONFIRMED ON SITE
- 6. STRUCTURAL ENGINEER TO CONFIRM DEPTH AND REINFORCEMENT
- 7. MIN 30 MPa CONCRETE OR BETTER


PAVING TYPE 1: CIP CONCRETE PAVING ON GRADE, TYP. Scale: 1:10

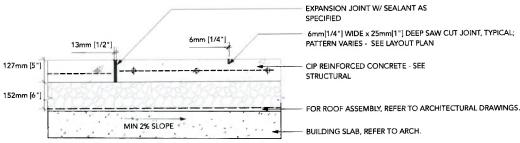

NOTES:


- 1. TROWEL WITH LIGHT SANDBLAST
- 2. SEE TYPICAL LAYOUT PLAN FOR JOINT PATTERN AND BAND WIDTH
- 3. EXP. JOINTS 6096mm [20'0"] O.C. MAX (@ CURB, BUILDING EDGE CUT LINES, CHANGES IN MATERIALS. SPACING TO COINCIDE W/ PATTERN)
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- 7. MIN 30 MPa CONCRETE OR BETTER

PAVING TYPE 1: CIP CONCRETE PAVING ON SLAB, TYP. Scale: 1:10

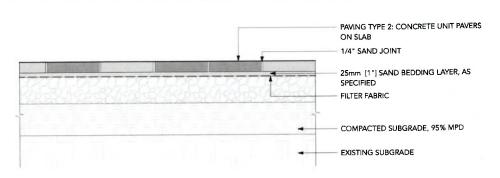


1. FINAL PRODUCT, COLOUR, AND PATTERN TBD BY OWNER.

PAVING TYPE 2: CONCRETE UNIT PAVERS ON GRADE, TYP.

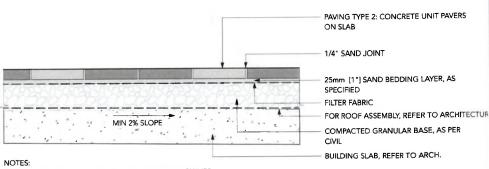

1. FINAL PRODUCT, COLOUR, AND PATTERN TBD BY OWNER.

PAVING TYPE 2: CONCRETE UNIT PAVERS ON SLAB, TYP.

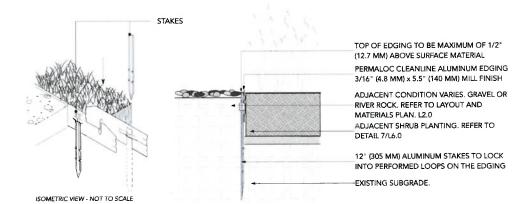

LANDSAFE BASE MAT, 2" MIN. TO 4" MAX. LANDSAFE 3/4" WEARING COURSE 4" COMPACTED AGGREGATE, SEE BASE SPECIFICATIONS DRAINBOARD, MEMBRANE, FLOOR ASSEMBLY, REFER TO ARCH MIN 2% SLOPE BUILDING SLAB, REFER TO ARCH

PAVING TYPE 3: ALUMINUM EDGE, TYP.

PAVING TYPE 5: LANDSAFE PLAY SURFACE WITHOUT CURB ON SLAB, TYP. Scale: 1:10

Gauthier + Associates Landscape Architects Inc.

Scale: 1:5





Gordon Head & Laval

Victoria, BC


SEBA Construction 2318 3982-84-86 Gordon Head Road May, 2023

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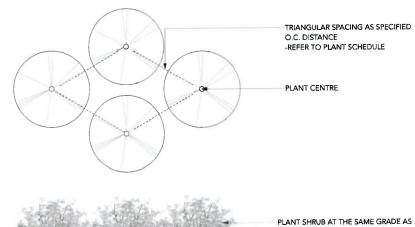


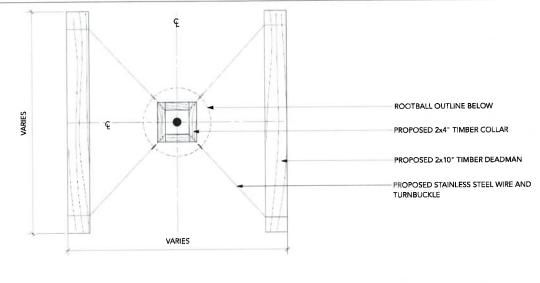


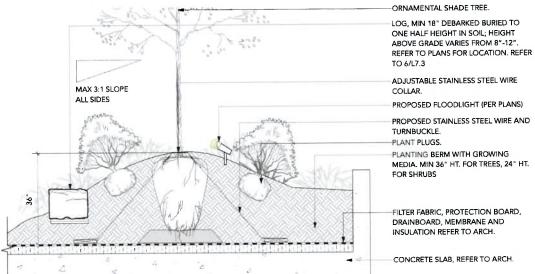GROUND LEVEL: TREE ON SLAB TYP. DETAIL Scale: 1:20

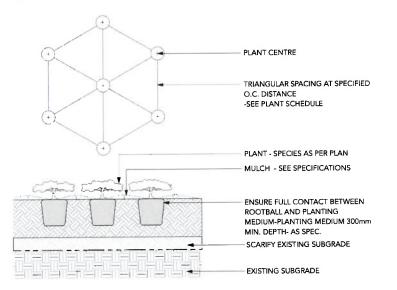

GROUNDCOVER PLANTING, TYP. DETAIL



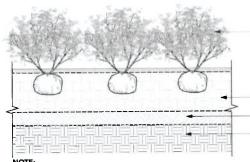

1. TRIANGULAR SPACING FOR IRREGULAR SHAPED PLANTERS; GRID SPACING FOR RECTINEAR
PLANTERS. AS SPECIFIED O.C. DISTANCE; ENSURE PERIMETER ROW

2. REFER TO PLANT SCHEDULE AND PLANTING

SHRUB ON GRADE TYP. DETAIL Scale: 1:20

PLANT SHRUB AT THE SAME GRADE AS NURSERY, WATER AND FERTILIZE AS SPEC. ALLOW FOR 2" DEPTH OF MULCH AS SPECIFIED. FINISH GRADE OF MULCH TO BE 2" BELOW FINISH GRADE OF ADJACENT WALL OR PAVING

GROWING MEDIUM, AS SPECIFIED

SCARIFY EXISTING SUBGRADE

EXISTING SUBGRADE

444

PLANT SHRUB AT THE SAME GRADE AS NURSERY, WATER AND FERTILIZE AS SPEC ALLOW FOR 2" DEPTH OF MULCH AS SPECIFIED. FINISH GRADE OF MULCH TO BE 2" BELOW FINISH GRADE OF ADJACENT WALL OR

-2" WASHED SAND (FILTER LAYER) FILTER FABRIC VOIDING IF REQUIRED - SEE ARCH

MEMBRANE, ROOT BARRIER, DRAIN MAT ASSEMBLY -SEE ARCH

REFER TO ARCHITECTURAL/STRUCTURAL DRAWINGS AND SPECIFICATIONS FOR BELOW GRADE CONDITIONS (INCLUDING BUT NOT LIMITED TO. FOOTINGS, REINFORCEMENT, BASE PREPARATION, DRAINAGE, MEMBRANE, DRAIN MAT, ETC.)

NOTE:


- 1. MIN. 18" PLANTING SOIL DEPTH + 2" MULCH DEPTH FOR SHRUBS ON SLAB.
- 2. FINISHED GRADE OF MULCH TO BE MIN. 1" BELOW ADJACENT PAVING, WALL OR STAIR.

SHRUB ON SLAB TYP. DETAIL

NOV 3 0 2023

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ADAPTER
BOTTOM OF THE POOL
TOP OF THE POOL
COMPOSTED MULCH, 50 – 70 MM DEPTH


BIO-RETENTION GROWING MEDIUM, 450 MM
DEPTH

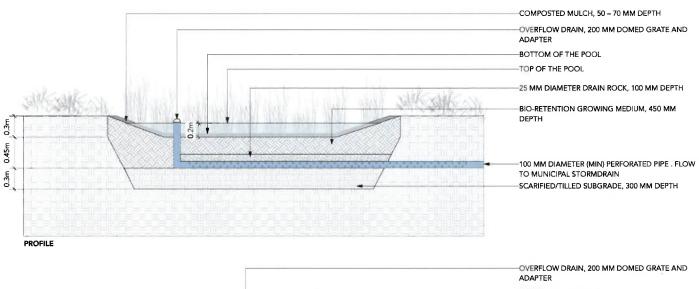
25 MM DIAMETER DRAIN ROCK, 100 MM DEPTH

100 MM DIAMETER (MIN) PERFORATED PIPE . FLOW
TO MUNICIPAL STORMDRAIN

SCARIFIED/TILLED SUBGRADE, 300 MM DEPTH

1 RAIN GARDEN ON GRADE, TYP. DETAIL Scale: 1:25

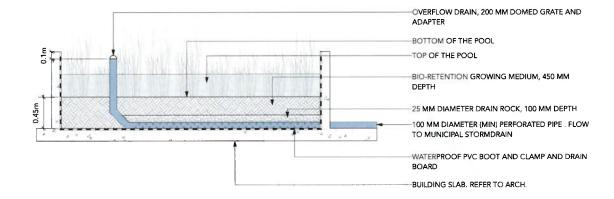

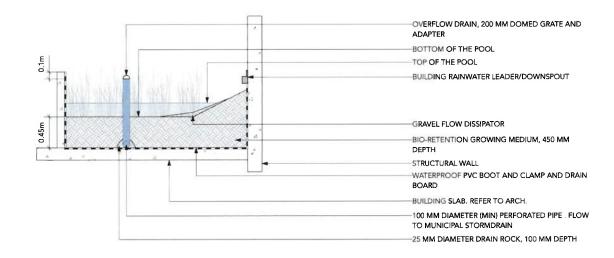


2 RAIN GARDEN ON SLAB, TYP. DETAIL Scale: 1:25










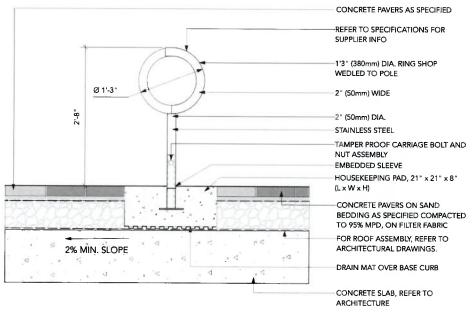

CLASS B BIKE RACK DETAIL BY SHOLTO Scale: 1:10



PLAN B

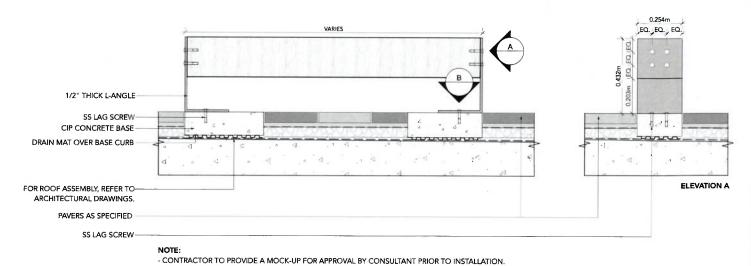

2 CUT TIMBER BENCH Scale: 1:10





Victoria, BC

3982-84-86 Gordon Head Road